
clearwre

WESTON MANOR MA-BOS5089-A / BS13XC671 15 WESTON AVENUE SOMERVILLE, MA 02144

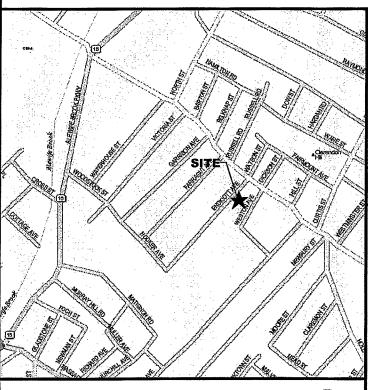

VICINITY MAP (NOT TO SCALE)



TAKE 93 TO ROUTE 60 - MEDFORD/MALDEN AT THE ROTARY TAKE 1ST EXIT TO SALEM STREET (ROUTE 60). MERGE ONTO MAIN STREET AND TAKE THE RT 16 WEST RAMP, MERGE ONTO MYSTIC VALLEY PARKWAY (ROUTE 16). AT THE ROTARY TAKE THE 2ND EXIT ONTO ALEWIFE BROOK PKWY/MA16 WEST. TURN LEFT ONTO BROADWAY. THIS IS AN UNMANNED TELECOMMUNICATION FACILITY CONSISTING OF BTS EQUIPMENT, BH AND PANEL ANTENNAS.

- SIGNALS FROM THE ANTENNA SHALL NOT INTERFERE WITH ANY EXISTING COMMUNICATION SITES. ALL ITEMS SHOWN HEREON ARE EXISTING UNLESS OTHERWISE NOTED.
- 3. THIS IS AN UNMANNED FACILITY NO SOLID WASTE, THE SITE WILL CREATE NO TRASH, THUS REQUIRES NO DUMPSTER.
- DEVELOPMENT AND USE OF THE SITE WILL CONFORM TO ALL APPLICABLE CODES AND ORDINANCES.

EMERGENCY POWER SUPPLY IS A CELL PACK BATTERY SOURCE AND NOT A FLAMMABLE LIQUID SOURCE.

PROJECT DESCRIPTION

ALL WORK AND MATERIALS SHALL BE PERFORMED AND INSTALLED IN ACCORDANCE WITH THE CURRENT EDITIONS OF THE FOLLOWING CODES AS ADOPTED BY THE LOCAL GOVERNING AUTHORITIES.

CODE COMPLIANCE

- 1. MASSACHUSETTS STATE BUILDING CODE
- 2. NEC 2008

SHEET	DESCRIPTION
T-1	TITLE SHEET
G-1	GENERAL NOTES
C-1	50' ABUTTERS MAP
A1	ROOF TOP PLAN & EQUIPMENT LAYOUT
A-2	EAST ELEVATION
A-3	SOUTH & NORTH ELEVATIONS
A-4	CONSTRUCTION DETAILS
A5	CABINET DETAILS
S-1	STRUCTURAL DETAILS
E-1	ELECTRICAL & GROUNDING SCHEMATIC
E-2	ANTENNA GROUNDING DETAILS

SHEET INDEX

CONSULTANTS: MAXTON TECHNOLOGY, INC. 241 BOSTON POST RD WEST MARLBOROUGH, MA 01752

PHONE: 508-229-4100 FAX: 508-485-5321

SITE APPLICATION:

BAY STATE DESIGN, INC. ARCHITECTS . ENGINEERS

241 BOSTON POST RD WEST MARLBOROUGH, MA 01752

PHONE: 508-229-4100 FAX: 508-485-5321

STRUCTURAL ENGINEER:

BAY STATE DESIGN, INC. RAMASASTRY SATYAPRASAD

ELECTRICAL ENGINEER:

BAY STATE DESIGN, INC. TRICHUR A. VENKATARAMAN

LOCAL POWER COMPANY: NSTAR

DO NOT SCALE DRAWINGS

CONTRACTOR SHALL VERIFY ALL PLANS AND EXISTING DIMENSIONS AND CONDITIONS ON THE JOB SITE AND SHALL IMMEDIATELY NOTIFY THE ARCHITECT IN WRITING OF ANY DISCREPANCIES BEFORE PROCEEDING WITH THE

UNDERGROUND

SERVICE ALERT

CALL TOLL FREE

1-888-DIG-SAFE

THREE WORKING DAYS BEFORE YOU DIG

clearw're

SUITE 300 KIRKLAND, WA 98033



WESTON MANOR


HOST #:

BS13XC671

MA-BOS5089-A

CONSTRUCTION DWG'S

10/28/09 REV. PER COMMENTS 0 10/14/09 FOR CONSTRUCTION A 07/10/09 ISSUED FOR REVIEW

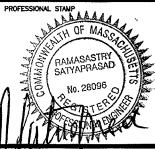

CHECKED BY: JT /F

JOB #:

2900.098

SITE ADDRESS:

15 WESTON AVENUE SOMERVILLE, MA 02144

SHEET TITLE:

TITLE SHEET

SHEET NUMBER:

T-1

ROOF TOP EQUIPMENT CABINETS & LATITUDE: N 42° 24' 12.51"

LONGITUDE: W 71° 07' 45.61" 67.0' A.M.S.L.

15 WESTON AVE. SOMERVILLE, MA 02144

JOSEPH MACALUSO P: 617-625-4522

RB- RESIDENTIAL B

SOMERVILLE HOUSING AUTHORITY

NB- NEIGHBORHOOD BUSYNESS

HANDICAP REQUIREMENTS:

APPLICANT / LESSEE

5808 LAKE WASHINGTON BLVD. NE

PROPERTY INFORMATION

CLEARWIRE

OWNER:

CONTACT:

PARCEL ID:

STRUCTURE TYPE:

GROUND ELEVATION:

COORDINATES:

ZONING:

SUITE 300 KIRKLAND, WA 98033

FACILITY IS UNMANNED AND NOT FOR HUMAN HABITATION. HANDICAPPED ACCESS NOT REQUIRED

PROJECT SUMMARY

PROJECT TEAM

DRIVING DIRECTIONS

GEN. CONTRACTOR NOTES

GENERAL NOTES

1. GENERAL

- 1. EXAMINE THE SITE CONDITIONS VERY CAREFULLY AND THE SCOPE OF PROPOSED WORK TOGETHER WITH THE WORK OF ALL OTHER TRADES AND INCLUDE IN THE BID PRICE ALL COSTS FOR WORK SUCH AS EQUIPMENT AND WIRING MADE NECESSARY TO ACCOMMODATE THE SYSTEMS SHOWN AND SYSTEMS OF OTHER TRADES.
- SUBMITTAL OF BID INDICATES CONTRACTOR IS COGNIZANT OF ALL JOB SITE CONDITIONS AND WORK TO BE PERFORMED UNDER THIS CONTRACT.
- 3. PERFORM DETAILED VERIFICATION OF WORK PRIOR TO ORDERING THE EQUIPMENT AND COMMENCING CONSTRUCTION. ISSUE A WRITTEN NOTICE TO THE CONSULTANT OF ANY DISCREPANCIES.
- 4. OBTAIN ALL PERMITS, PAY ASSOCIATED FEES AND SCHEDULE INSPECTION.
- 5. PROVIDE ALL LABOR, MATERIAL, EQUIPMENT, INSURANCE AND SERVICES TO COMPLETE THIS PROJECT IN ACCORDANCE WITH THE CONTRACT DOCUMENTS AND PRESENT IT AS FULLY OPERATIONAL TO THE SATISFACTION OF THE OWNER.
- 6. CARRY OUT WORK IN ACCORDANCE WITH ALL GOVERNING STATE, COUNTY AND LOCAL CODES AND O.S.H.A.
- PRIOR TO BEGINNING WORK COORDINATE ALL POWER AND TELCO WORK WITH THE LOCAL UTILITY COMPANY AS IT MAY APPLY TO THIS SITE. ALL WORK TO COMPLY WITH THE RULES AND REGULATIONS OF THE UTILITIES INVOLVED.
- 8. FABRICATION AND INSTALLATION OF THE COMPLETE ELECTRICAL SYSTEM SHALL BE DONE IN A FIRST CLASS WORKMANSHIP PER NECA STANDARD 1~2000 BY QUALIFIED PERSONNEL EXPERIENCED IN SUCH WORK AND SHALL SCHEDULE THE WORK IN AN ORDERLY MANNER SO AS NOT TO IMPEDE PROGRESS OF THE PROJECT.
- 9. DURING PROGRESS OF THE WORK, MAINTAIN AN ACCURATE RECORD OF THE INSTALLATION OF THE SYSTEMS, LOCATING EACH CIRCUIT PRECISELY AND DIMENSIONING EQUIPMENT, CONDUIT AND CABLE LOCATIONS. UPON COMPLETION OF THE INSTALLATION, TRANSFER ALL RECORD DATA TO BLACK LINE PRINTS OF THE ORIGINAL DRAWINGS AND SUBMIT THESE DRAWINGS AS RECORD DRAWINGS TO THE CONSULTANT.
- 10. COMPLETE JOB SHALL BE GUARANTEED FOR A PERIOD OF ONE (1) YEAR AFTER THE DATE OF JOB ACCEPTANCE BY OWNER. ANY WORK, MATERIAL, OR EQUIPMENT FOUND TO BE FAULTY DURING THAT PERIOD SHALL BE CORRECTED AT ONCE UPON WRITTEN NOTIFICATION, AT THE EXPENSE OF THE CONTRACTOR.
- 11. CONTRACTOR SHALL CONSULT MANUFACTURER'S PLANS, SHOP DRAWINGS AND SPECS FOR INDOOR/OUTDOOR EQUIPMENT LOCATION AND INSTALLATION, ALL ELECTRICAL EQUIPMENT SHALL BE INSTALLED IN ACCESSIBLE AREAS ONLY.
- 12. COORDINATE EXACT TELEPHONE REQUIREMENTS AND SERVICE ROUTING WITH LOCAL TELEPHONE SERVICE IMMEDIATELY UPON AWARD OF CONTRACT.
- 2. BASIC MATERIALS AND METHODS
- ALL ELECTRICAL WORK SHALL CONFORM TO THE EDITION OF THE NEC ACCEPTED BY THE LOCAL JURISDICTION AND TO THE APPLICABLE LOCAL CODES AND REGULATIONS.
- ALL MATERIALS AND EQUIPMENT SHALL BE NEW. MATERIALS AND EQUIPMENT SHALL BE THE STANDARD PRODUCTS OF MANUFACTURER'S CURRENT DESIGN. ANY FIRST-CLASS PRODUCT MADE BY A REPUTABLE MANUFACTURER MAY BE USED PROVIDING IT CONFORMS TO THE CONTRACT REQUIREMENTS AND MEETS THE APPROVAL OF THE CONSULTANT AND THE OWNER.
- 3. ARRANGE CONDUIT, WIRING, EQUIPMENT AND OTHER WORK GENERALLY AS SHOWN, PROVIDING PROPER CLEARANCES AND ACCESS. CAREFULLY EXAMINE ALL CONTRACT DRAWINGS AND FIT WHERE DEPARTURES ARE PROPOSED BECAUSE OF FIELD CONDITIONS OR OTHER CAUSES, PREPARE AND SUBMIT DETAILED DRAWINGS FOR ACCEPTANCE.
- 4. THE CONTRACT DRAWINGS ARE GENERALLY DIAGRAMMATIC AND ALL OFFSETS, BENDS, FITTINGS AND ACCESSORIES ARE NOT NECESSARILY SHOWN. PROVIDE ALL SUCH ITEMS AS MAY BE REQUIRED TO FIT THE WORK TO THE CONDITIONS
- 5. MAINTAIN ALL CLEARANCES AS REQUIRED BY NEC.
- SEAL AROUND CONDUITS AND AROUND CONDUCTORS WITHIN CONDUITS ENTERING THE PREFABRICATED SHELTER/CABINETS WHERE PENETRATION OCCURS WITH A SILICONE SEALANT TO PREVENT MOISTURE PENETRATION INTO
- SILICONE SEAL AROUND ALL BOLTS AND SCREWS USED TO SECURE EQUIPMENT TO EXTERIOR OF BUILDING.

3. RACEWAYS AND BOXES

- 1. ALL CONDUIT SHALL BE UL LABELED.
- 2. ALL EMPTY CONDUITS INSTALLED FOR FUTURE USE SHALL HAVE A PULL CORD.
- SHEET METAL BOXES SHALL CONFORM TO NEMA 051; CAST-METAL BOXES SHALL CONFORM TO NEMA 81 AND SHALL BE SIZED IN ACCORDANCE WITH NEC UNLESS NOTED OTHERWISE.
 - 4. GROUNDING
- ALL SAFETY GROUNDING OF THE ELECTRICAL EQUIPMENT SHALL BE CARRIED OUT IN ACCORDANCE WITH THE CURRENT REVISION NEC.
- ALL GROUND LUG AND COMPRESSION CONNECTIONS SHALL BE COATED WITH ANTI-OXIDANT AGENT, SUCH AS NO-OX, NOALOX, PENETROX OR KOPRSHIELD.
- GROUND ALL EXPOSED METALLIC OBJECTS ON BUILDING EXTERIOR INCLUDING BUILDING TIE DOWN BRACKETS.
- PROVIDE LOCK WASHERS FOR ALL MECHANICAL CONNECTIONS FOR GROUND CONDUCTORS. USE STAINLESS STEEL HARDWARE THROUGHOUT.
- 5. DO NOT INSTALL GROUND RING OUTSIDE OF PROPERTY LINE.
- REMOVE ALL PAINT AND CLEAN ALL DIRT FROM SURFACES REQUIRING GROUND CONNECTIONS, REPAINT TO MATCH AFTER CONNECTION IS MADE TO MAINTAIN CORROSION RESISTANCE.
- 7. ALL EXTERIOR GROUNDING CONDUCTORS INCLUDING EXTERIOR GROUND RING SHALL BE #2 AWG SOLID BARE TINNED COPPER UNLESS NOTED OTHERWISE. MAKE ALL GROUND CONNECTIONS AS SHORT AND DIRECT AS POSSIBLE. AVOID SHARP BENDS. THE RADIUS OF ANY BEND SHALL NOT BE LESS THAN 8" AND THE ANGLE OF ANY BEND SHALL NOT EXCEED 90'. GROUNDING CONDUCTORS SHALL BE ROUTED DOWNWARD TOWARD THE BURIED GROUND RING.
- 8. BOND ALL EXTERIOR CONDUITS, PIPES AND CYLINDRICAL METALLIC OBJECTS WITH A PENN-DINION GT SERIES CLAMP, BLACKBURN GUV SERIES CLAMP OR A BURNOY GAR 3900BU SERIES CLAMP ONLY, NO SUBSTITUTES ACCEPTED.
- 9. ALL GROUND CONNECTIONS SHALL BE APPROVED FOR THE METALS BEING CONNECTED.
- 10. ALL EXTERNAL GROUND CONNECTIONS SHALL BE EXOTHERMICALLY WELDED. ALL EXOTHERMIC WELDS TO EXTERIOR GROUND RING SHALL BE THE PARALLEL TYPE, EXCEPT FOR THE GROUND RODS WHICH ARE TEE EXOTHERMIC WELDS. REPAIR ALL CALVANIZED SURFACES THAT HAVE BEEN DAMAGED BY EXOTHERMIC WELDING. USE SPRAY GALVANIZER SUCH AS HOLUB LECTROSOL #15-501.
- 11. CONTRACTOR SHALL NOTIFY THE CONSTRUCTION MANAGER WHEN THE BURIED GROUND RING IS INSTALLED SO THE REPRESENTATIVE CAN INSPECT THE GROUND RING BEFORE IT IS BACKFILLED WITH SOIL.
- 12. FOR METAL FENCE POST GROUNDINGS, USE A HEAVY DUTY TYPE GROUNDING CLAMP OR EXOTHERMIC WELD CONNECTION TO POST. GROUND ALL FENCE POSTS WITHIN 6' OF EQUIPMENT.
- 13. WHERE MECHANICAL CONNECTORS (TWO-HOLE OR CLAMP) ARE USED, APPLY A LIBERAL PROTECTIVE COATING OF AN ANTI-OXIDE COMPOUND SUCH AS "NO OXIDE A" BY DEARBORN CHEMICAL COMPANY ON ALL CONNECTORS.

PROJECT INFORMATION

5. COAXIAL ANTENNA CABLE NOTES

- THE COAXIAL ANTENNA CABLE INSTALLER SHALL BE RESPONSIBLE FOR PERFORMING AND SUPPLYING CLEARWIRE WITH TYPE-WRITTEN SWEEP TESTS (ANTENNA RETURN LOSS TEST). THIS TEST SHALL BE PERFORMED TO THE SPECIFICATIONS AND PARAMETERS OUTLINED BY THE CLEARWIRE RADIO FREQUENCY (RF) ENGINEER. THIS TEST SHALL BE PERFORMED PRIOR TO FINAL ACCEPTANCE PF SITE.
- 2. VAPOR WRAP WILL BE USED TO SEAL ALL CONNECTIONS.
- ALL COAXIAL CABLE WILL BE GROUNDED PRIOR TO ENTERING THE EQUIPMENT SPACE AND AS SPECIFIED IN THE ELECTRICAL DRAWINGS.
- ALL MAIN TRANSMISSION CABLE WILL BE TERMINATED AT A NEW/EXISTING POLYPHASER SURGE PROTECTOR LOCATED WITH THE EQUIPMENT SPACE,
- ALL COAXIAL CABLE WILL BE SECURED TO THE DESIGNED SUPPORT STRUCTURE AT DISTANCES NOT TO EXCEED 4'-0" WITH HARDWARE SPECIFIED IN THE COAXIAL CABLE ROUTING DETAILS.
- 6. ANTENNA CABLE LENGTHS HAVE BEEN PROVIDED BY OTHERS. CABLE LENGTHS LISTED ARE APPROXIMATE AND ARE NOT INTENDED TO BE USED FOR FABRICATION DUE TO FIELD CONDITIONS. ACTUAL ANTENNA CABLE LENGTHS REQUIRED MAY VARY FROM LENGTHS TABULATED. CONTRACTORS MUST FIELD VERIFY ANTENNA CABLE LENGTHS PRIOR TO ORDER.
- 7. ALL MAIN CABLES WILL BE COLOR CODED AT THREE (3) LOCATIONS:
- ALL TOP JUMPERS WILL BE MADE UP OF 1/2" DIA. LDF. THE CONTRACTOR SHALL USE ALL REASONABLE EFFORTS TO MINIMIZE THE LENGTH OF THE JUMPERS

LEGEND

SYMBOL DESCRIPTION

СВ CIRCUIT BREAKER \Box NON-FUSIBLE DISCONNECT SWITCH F FUSIBLE DISCONNECT SWITCH SURFACE MOUNTED PANEL BOARD T TRANSFORMER

KILOWATT HOUR METER

EXOTHERMIC WELD CONNECTION

PIN AND SLEEVE RECEPTACLE

GROUND ROD WITH INSPECTION SLEEVES

MECHANICAL CONNECTION

----0 DENOTES CABLE OR CONDUIT TURNING DOWN IN PLAN VIEW

<u>(M)</u>

4

77

-€

AIC:

BFG

CRGB

- JB JUNCTION BOX PB PULL BOX TO NEC/TELCO STANDARDS
- ---- ОНО --OVERHEAD UTILITIES ____ UGT -----UNDERGROUND TELCO
- ____ IIGP _ UNDERGROUND POWER (x-x)DENOTES REFERENCE NOTE

- A. AT ANTENNA PRIOR TO JUMPER B. PRIOR TO ENTERING EQUIPMENT CABINET, AT CABLE ENTRY PORT C. INTERIOR SIDE OF EQUIPMENT CABINET, AT CABLE ENTRY PORT
- 8. ALL MAIN CABLES WILL BE GROUNDED AT:
 - A. AT ANTENNA MOUNTING PIPE
 B. AT CABLE SUPPORT ASSEMBLY ON ROOF
 C. PRIOR TO ENTERING EQUIPMENT CABINET

5808 LAKE WASHINGTON BLVD. NE SUITE 300 KIRKLAND, WA 98033



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SITE NAME:

APPLICANT:

WESTON MANOR

BS13XC671

SITE #:

MA-BOS5089-A

CHECKED BY: JT/RS

2900.098

15 WESTON AVENUE

SOMERVILLE, MA 02144

GENERAL NOTES

CONSTRUCTION DWG'S

ABBREVIATIONS

GROUND BAR

GROUND CONDUCTOR

- AFG ABOVE FINISHED GRADE 1 10/28/09 REV. PER COMMENTS AMPERE INTERRUPTING CAPACITY 10/14/09 FOR CONSTRUCTION BELOW FINISHED GRADE
 - A 07/10/09 ISSUED FOR REVIEW CONDUIT CELL REFERENCE GROUND BAR PROFESSIONAL STAMP MASSAGE STATE OF MASSAG

RAWN BY: KO

SITE ADDRESS:

SHEET TITLE:


SHEET NUMBER


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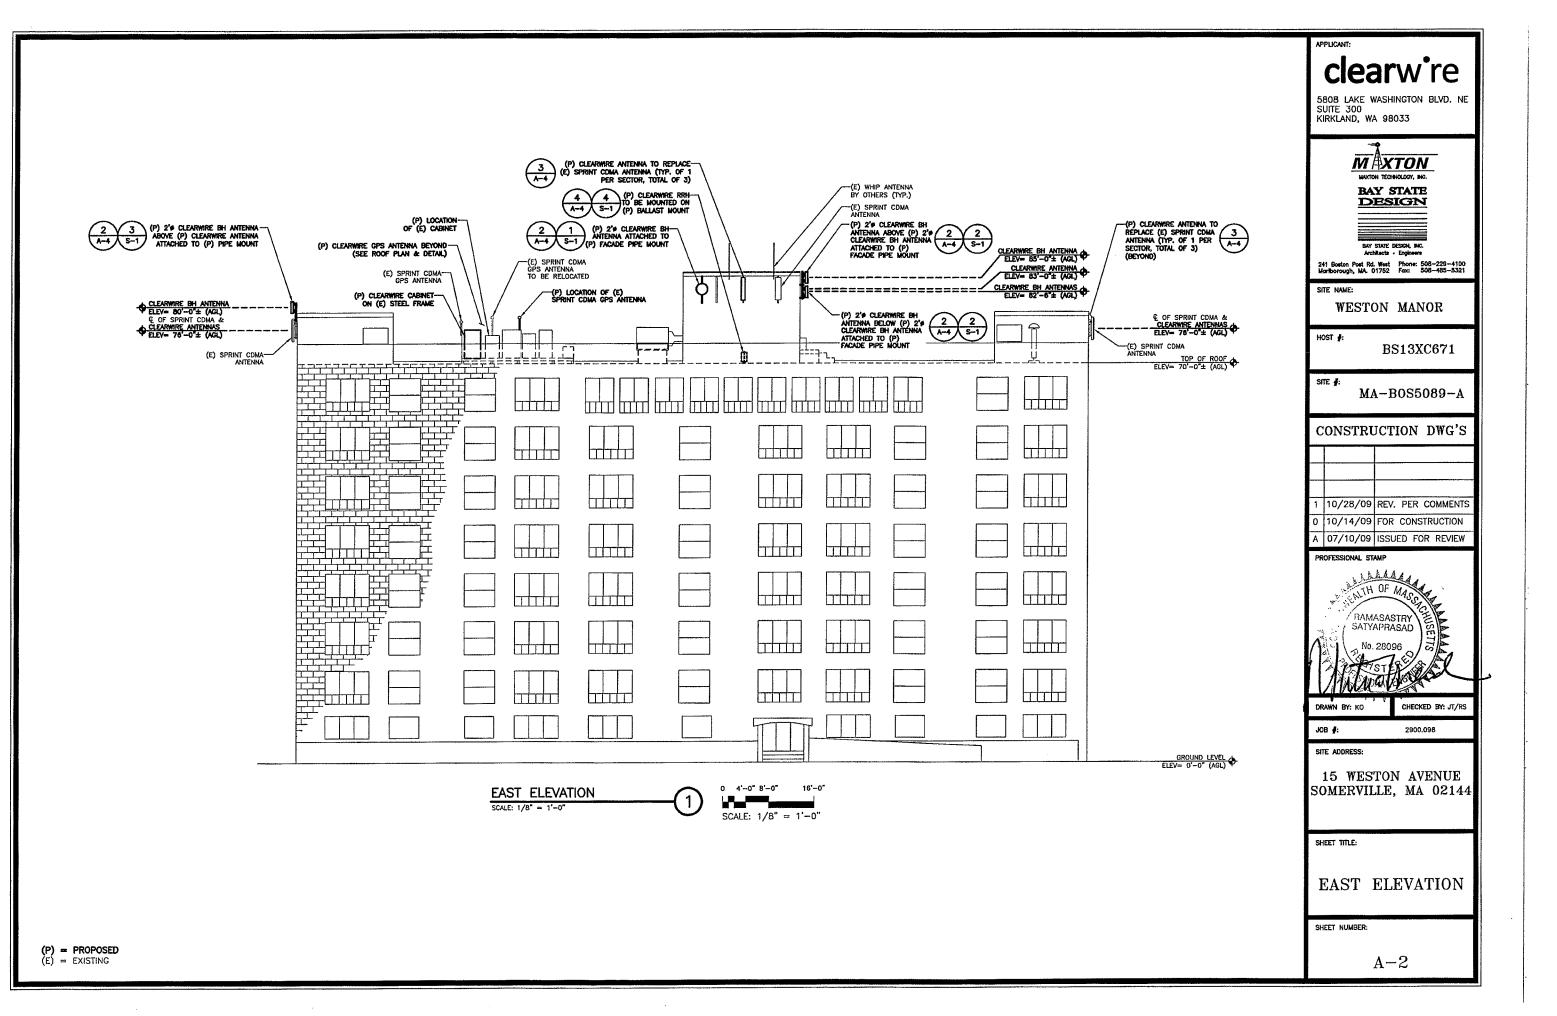
- CU COPPER COMPLETE WITH C/W D.T.T. DRY TYPE TRANSFORMER
- DIAMETER DIA. EMPTY CONDUIT EC
- EMT ELECTRO MAGNETIC TUBING
- GROUNDING ELECTRODE
- GEC GROUNDING ELECTRODE CONDUCTOR
- GALVANIZED RIGID CONDUIT GRC MANUAL TRANSFER SWITCH MTS
- NEC NATIONAL ELECTRICAL CODE OVERHEAD O/H
- POWER DISTRIBUTION CABINET PDC POLYVINYL CHLORIDE PVC
- RIGID NON-METALLIC CONDUIT RNC SCHED SCHEDULE
- SD SERVICE DISCONNECT SWITCH SE SERVICE ENTRANCE
- SOLID NEUTRAL TGB TELCO GROUND BAR TOWER EXIT GROUND BAR TEGB
- TRANSFORMER TRANSIENT VOLTAGE SURGE SUPPRESSOR TVSS
- TYPICAL TYP UNDERGROUND U/G WEATHERPROOF - NEMA 3R


WP


G-1



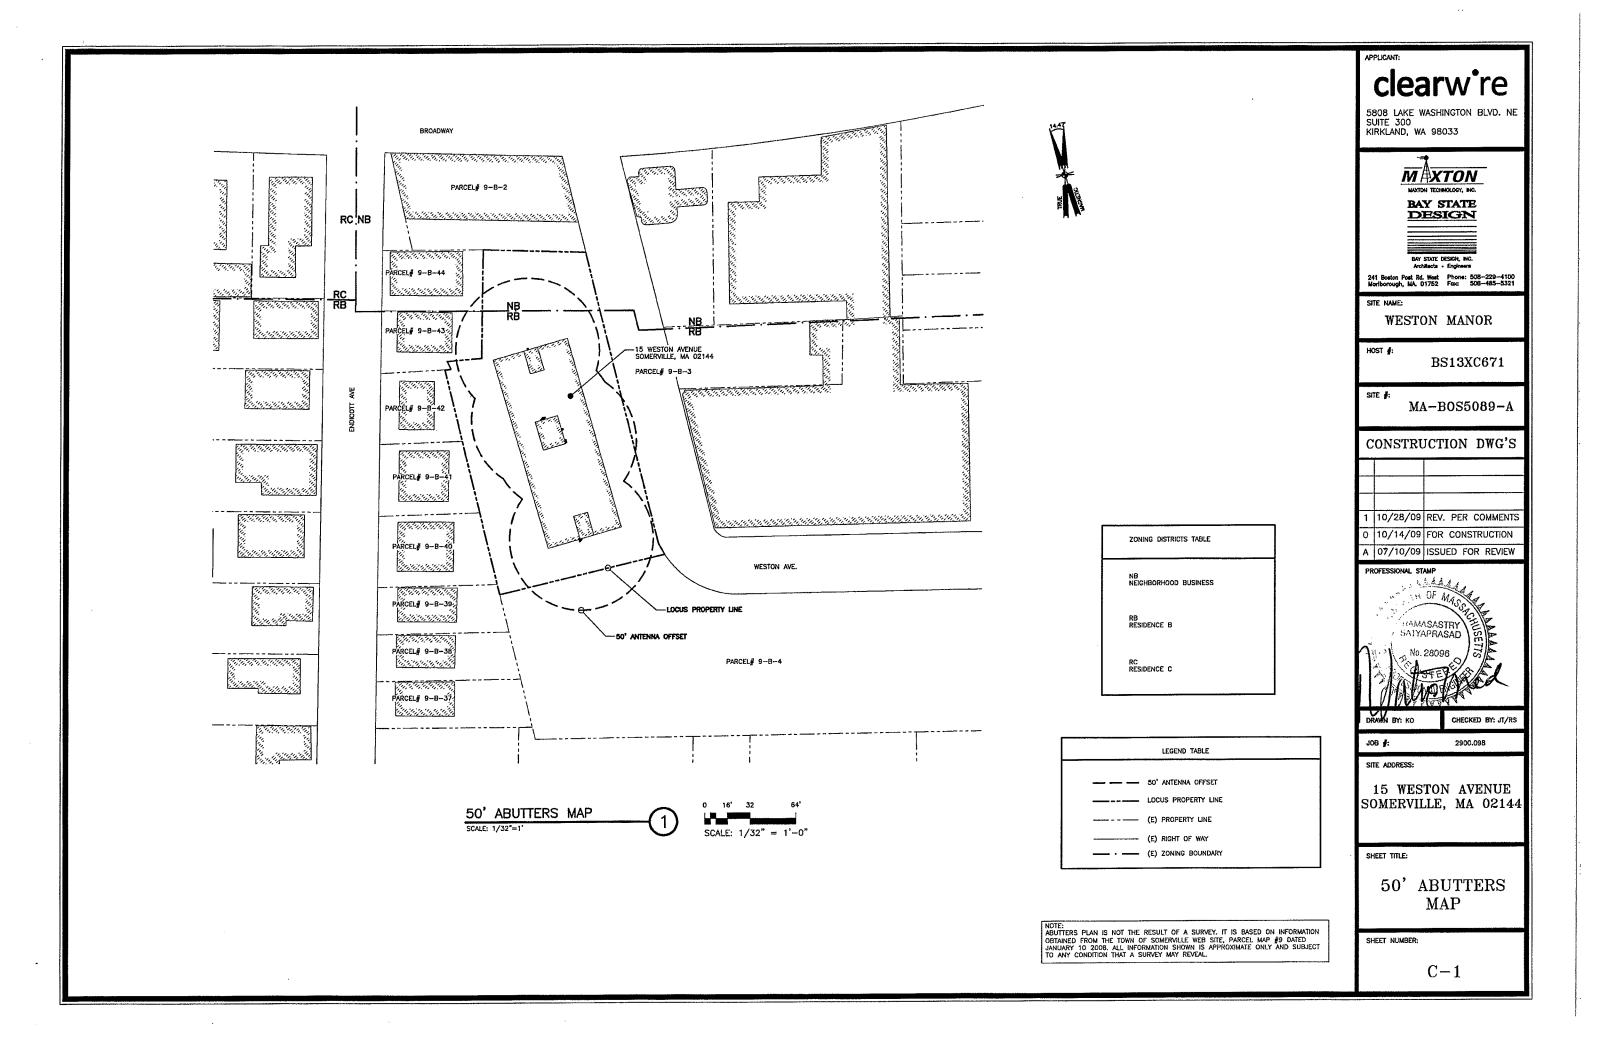

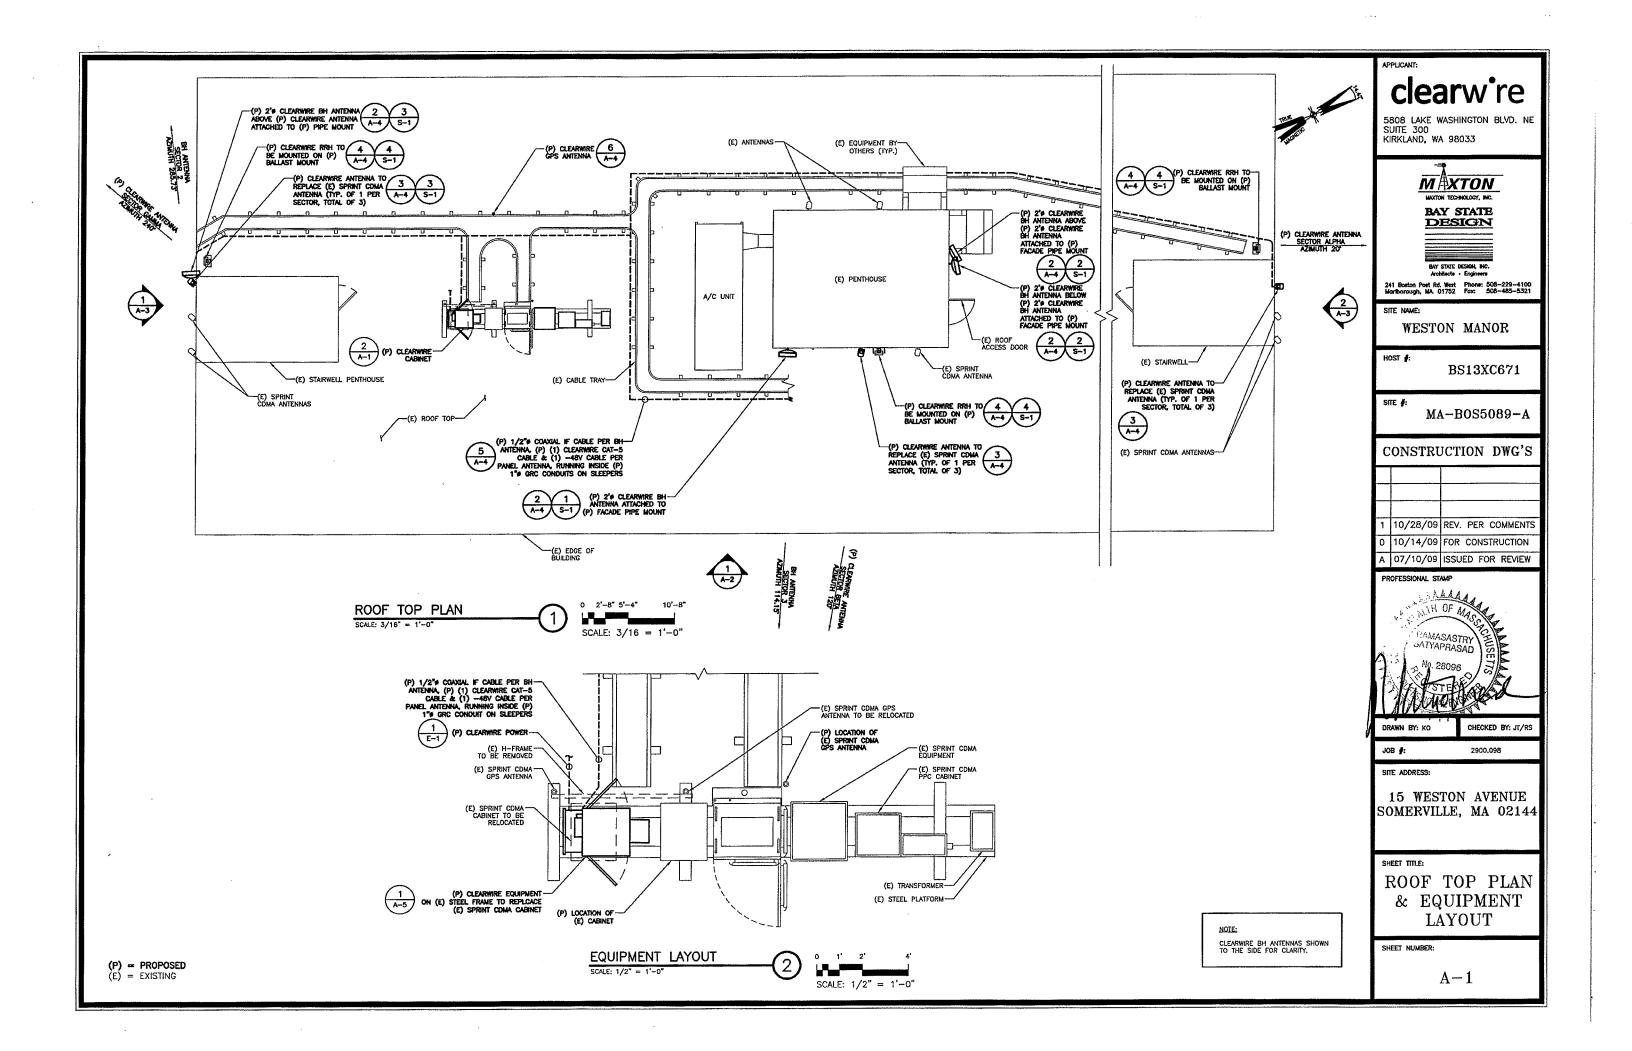

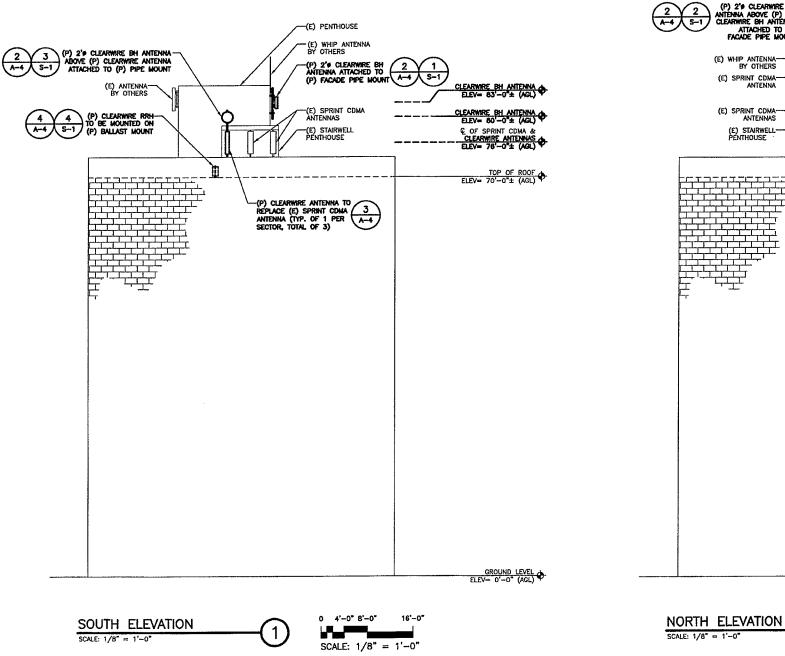

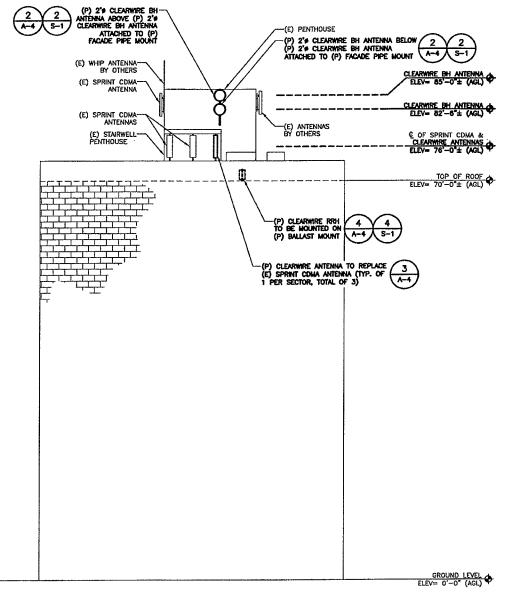

0 4'-0" 8'-0" 15'-0"

SCALE: 1/8" = 1'-0"

clearw re

5808 LAKE WASHINGTON BLVD. NE SUITE 300 KIRKLAND, WA 98033



BAY STATE DESIGN

BAY STATE DESIGN, INC. Architects - Engineers

241 Boston Post Rd. West Phone: 508-229-4100 Morlborough, MA. 01752 Fax: 508-485-5321

WESTON MANOR

HOST #:

BS13XC671

MA-BOS5089-A

CONSTRUCTION DWG'S

1 10/28/09 REV. PER COMMENTS 0 10/14/09 FOR CONSTRUCTION

A 07/10/09 ISSUED FOR REVIEW



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2900.098

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SHEET TITLE:

SOUTH & NORTH **ELEVATIONS**

SHEET NUMBER:

A-3

CLEARWIRE ANTENNA INFORMATION POWER CABLE SIZE CAT-5 CABLE SIZE COAXIAL IF CABLE SIZE COAX CABLE SIZE RET CABLE SIZE ANTENNA BAND # AZIMUTH MODEL DOWNTILT 5/16"≠ ARGUS LLPX310R 76'-0" 5/8"# 1/2"# RED 20" 5/16"# ARGUS LLPX310R 83'-0" 1/2"# BLUE 120 5/8"# 5/16*# YELLOW. 240* ARGUS LLPX310R O 76'-0" 5/8 9 1/2" 82'-6" VHLP2 2'# BH ANT. 18 8.20 DRAGONWAVE 1/2" 80'-0" 2'9 BH ANT. 18 285.73 DRAGONWAVE VHLP2 1/2"9 18 114.15 DRAGONWAVE VHLP2 0 83'-0" 1/2" 2'# BH ANT. 85'-0" 2'# 8H ANT. 18 350.42' DRAGONWAVE 1/2"ø VHLP2 1/2"# 1 GPS GPS ANTENNA LOCATION OPTIONS: (1) CABLE TRAY; (2) ANTENNA MAST; (3) H-FRAME; FIELD VERIFY *MW INFORMATION BASED ON MW INTERCONNECT DATA DATED 09/24/09

LABEL MARKINGS SHALL BE PLACED AT:

- 1. WITHIN 12" OF CABLE AT BOTH ENDS
- 2. AT/NEAR TOWER MGB

-

-

ANTENNA DIMENSIONS

ANTENNA WEIGHT


3. EITHER PRIOR TO ENTRY INTO THE CABINET FOR A CABLE SUPPORT BRIDGE

11.8"

* COORDINATE BACKHAUL INSTALLATION WITH FINAL ENGS


MICROWAVE LINE COLOR CHART							
		LSB				MSB	
	CABLE	STRIPE 1	STRIPE 2	STRIPE 3	STRIPE 4 (8)	STRIPE 5 (16)	
	1	YELLOW	PURPLE	PURPLE	PURPLE	PURPLE	
	2	PURPLE	YELLOW	PURPLE	PURPLE	PURPLE	
	3	YELLOW	YELLOW	PURPLE	PURPLE	PURPLE	
	4	PURPLE	PURPLE	YELLOW	PURPLE	PURPLE	


CLEARWIRE ANTENNA INFORMATION & COLOR CODING SCALE: N.T.S.

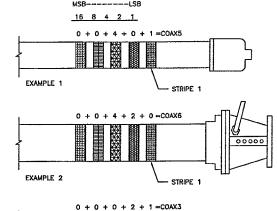

STRIPE 1

NOTE: STRIPE 1 SHALL BE PLACED CLOSEST TO THE CONNECTOR END OF THE CABLE.

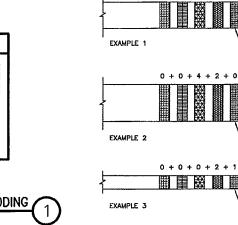


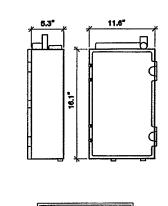


MANUFACTURER: SAMSUNG HEIGHT: 16.1" WIDTH: 11.6" DEPTH: 5.3" WEIGHT: 35 LBS

NOTE: INSTALL RRH BEHIND PANEL ANTENNA PER MANUFACTURER'S SPECIFICATIONS

SAMSUNG REMOTE RADIO HEAD (RRH)

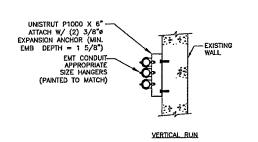

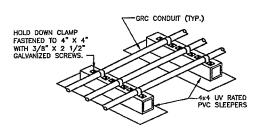


MOUNTING DETAIL

SCALE: N.T.S


HORIZONTAL RUN ON ROOFTOP **EMT CONDUIT**

A 663 (26.10) B 358 (14.10) C 143 (5.60)

D 335 (13.30)

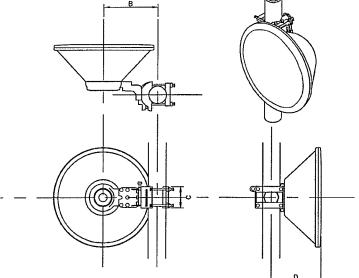

2'ø DRAGONWAVE VHLP2 BACKHAUL ANTENNA (TYP.)

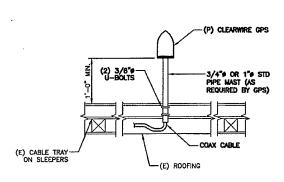

ELEVATION

1. LOCATION OF ANTENNA MUST HAVE CLEAR VIEW OF SKY AND CANNOT HAVE ANY BLOCKAGES EXCEEDING 25% OF THE SURFACE AREA OF A HEMISPHERE AROUND THE GPS ANTENNA.

2. ALL GPS ANTENNA LOCATIONS <u>MUST. BE</u> ABLE TO RECEIVE CLEAR SIGNALS FROM A MINIMUM OF FOUR (4) SATELLITES. VERIFY WITH HANDHELD GPS BEFORE FINAL LOCATION OF GPS ANTENNA.

GPS ANTENNA PIPE MOUNT SCALE: NTS

APPLICANT: **clearw** re

5808 LAKE WASHINGTON BLVD. NE SUITE 300 KIRKLAND, WA 98033



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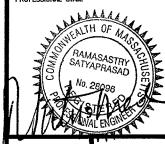
SITE #:

MA-BOS5089-A

CONSTRUCTION DWG'S

	1	10/28/09	REV. PER COMMENTS
	0	10/14/09	FOR CONSTRUCTION
1	Α	07/10/09	ISSUED FOR REVIEW

PROFESSIONAL STAMP



CHECKED BY: JT/RS

JOB #:

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SITE ADDRESS:


15 WESTON AVENUE SOMERVILLE, MA 02144

SHEET TITLE:

CONSTRUCTION **DETAILS**

SHEET NUMBER:

A-4

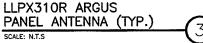


LLPX310R ARGUS PANEL ANTENNA

42"x11.8"x4.5"

28.65 LBS.

(P) = PROPOSED (E) = EXISTING

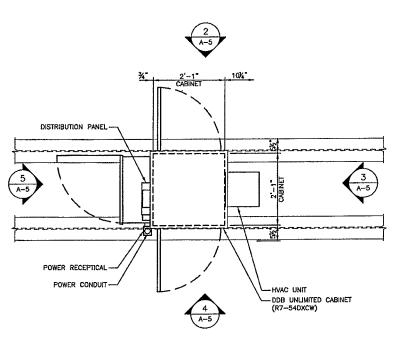

EQUIPMENT PLAN

SCALE: 3/4" = 1'-0"

BATTERY INFORMATION:

BATTERY_INFORMATION:

LONG DURATION SERIES — TEL 12-70

1. FLAM E-ARRESTING ONE-WAY PRESSURE-RELIEF
VENT FOR SAFETY AND LONG LIFE.

2. THERMALLY WELDED CASE-TOOCOVER BOND TO
ENSURE A LEAK-PROOF SEAL.


3. FLAME-RETARDANT POLYPROPYLENE CASE AND
COVER COMPLIANT WITH UL94 V-O WITH AN OXYGEN
LIMITING INDEX OF GREATER THAN 28.

4. COMPLIES WITH UL 1778, 924, 1989 AND 94 V-O.


5. UL-RECOGNIZED COMPONENT.


6. NOT RESTRICTED FOR SURFACE
TRANSPORT-CLASSIFIED AS NON-HAZARDOUS MATERIAL
AS RELATED TO DOT-CFR TITLE 49 PARTS 171-189.

TEL 12-70 SPECIFICATIONS:
CELLS PER UNIT = 6
VOLTAGE PER UNIT = 12.84
WEIGHT = 55 LBS
ELECTROLYTE = ABSORBED H2SO4 / SG = 1.300
VOLUME: 8.02" X 10.17" X 6.65" = 542.40 cu in
MAX = 4

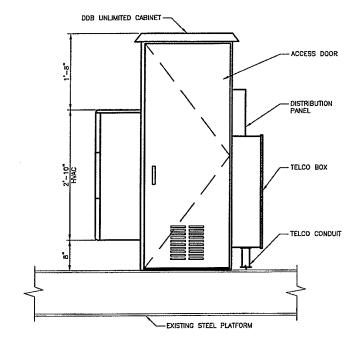


CABINET ELEVATION (BACK)

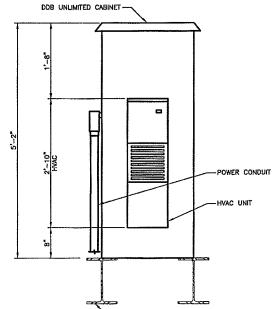

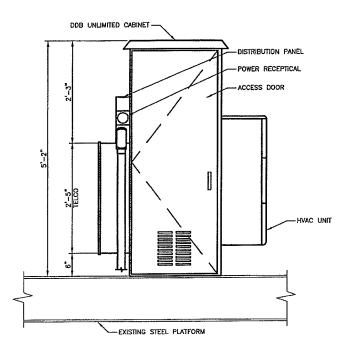

CABINET ELEVATION (FRONT)

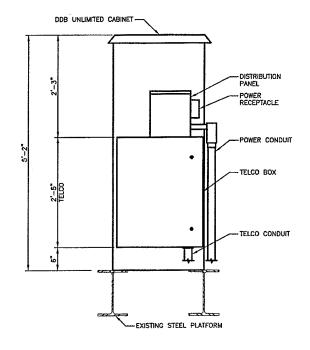

CABINET ELEVATION (RIGHT)

clearw're

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WESTON MANOR


HOST #:

BS13XC671

MA-BOS5089-A

CONSTRUCTION DWG'S

1	10/28/09	REV. PER COMMENTS
0	10/14/09	FOR CONSTRUCTION
Α	07/10/09	ISSUED FOR REVIEW

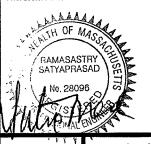

DRAWN BY: KO

CHECKED BY: JT/RS

JOB #:

2900.098

SITE ADDRESS:

15 WESTON AVENUE SOMERVILLE, MA 02144

SHEET TITLE:


CABINET DETAILS

SHEET NUMBER:

A-5

EXISTING STEEL PLATFORM CABINET ELEVATION (LEFT)


(P) = PROPOSED (E) = EXISTING

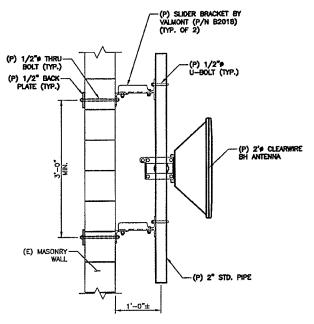


BH ANTENNA

SCALE: 1" = 1'-0"

PIPE MOUNT DETAIL

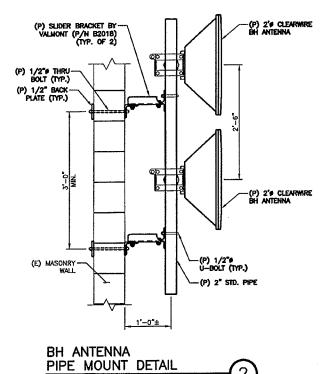


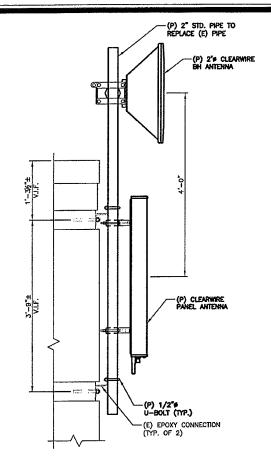

BH & PANEL ANTENNA
PIPE MOUNT DETAIL

SCALE: 1" = 1'-0"



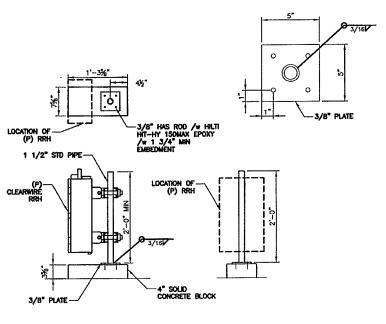

RRH MOUNTING DETAIL

SCALE: 1" = 1'-0"

4

-3


APPLICANT: **clearw**re 5808 LAKE WASHINGTON BLVD. NE SUITE 300 KIRKLAND, WA 98033 M AXTON BAY STATE
DESIGN BAY STATE DESIGN, INC. Architecta · Engineera 241 Boston Post Rd. West Phone: 508-229-4100 Monitorough, MA. 01752 Fax: 508-485-5321 WESTON MANOR HOST #: BS13XC671 SITE #: MA-BOS5089-A CONSTRUCTION DWG'S 1 10/28/09 REV. PER COMMENTS 0 10/14/09 FOR CONSTRUCTION A 07/10/09 ISSUED FOR REVIEW . OF MASS HAMASASTRY SATYAPRASAD CHECKED BY: JT/RS DRAWN BY: KO JOB #: 2900.098 SITE ADDRESS: 15 WESTON AVENUE SOMERVILLE, MA 02144 SHEET TITLE: STRUCTURAL


STRUCTURA DETAILS

SHEET NUMBER:

S-1


(P) = PROPOSED (E) = EXISTING

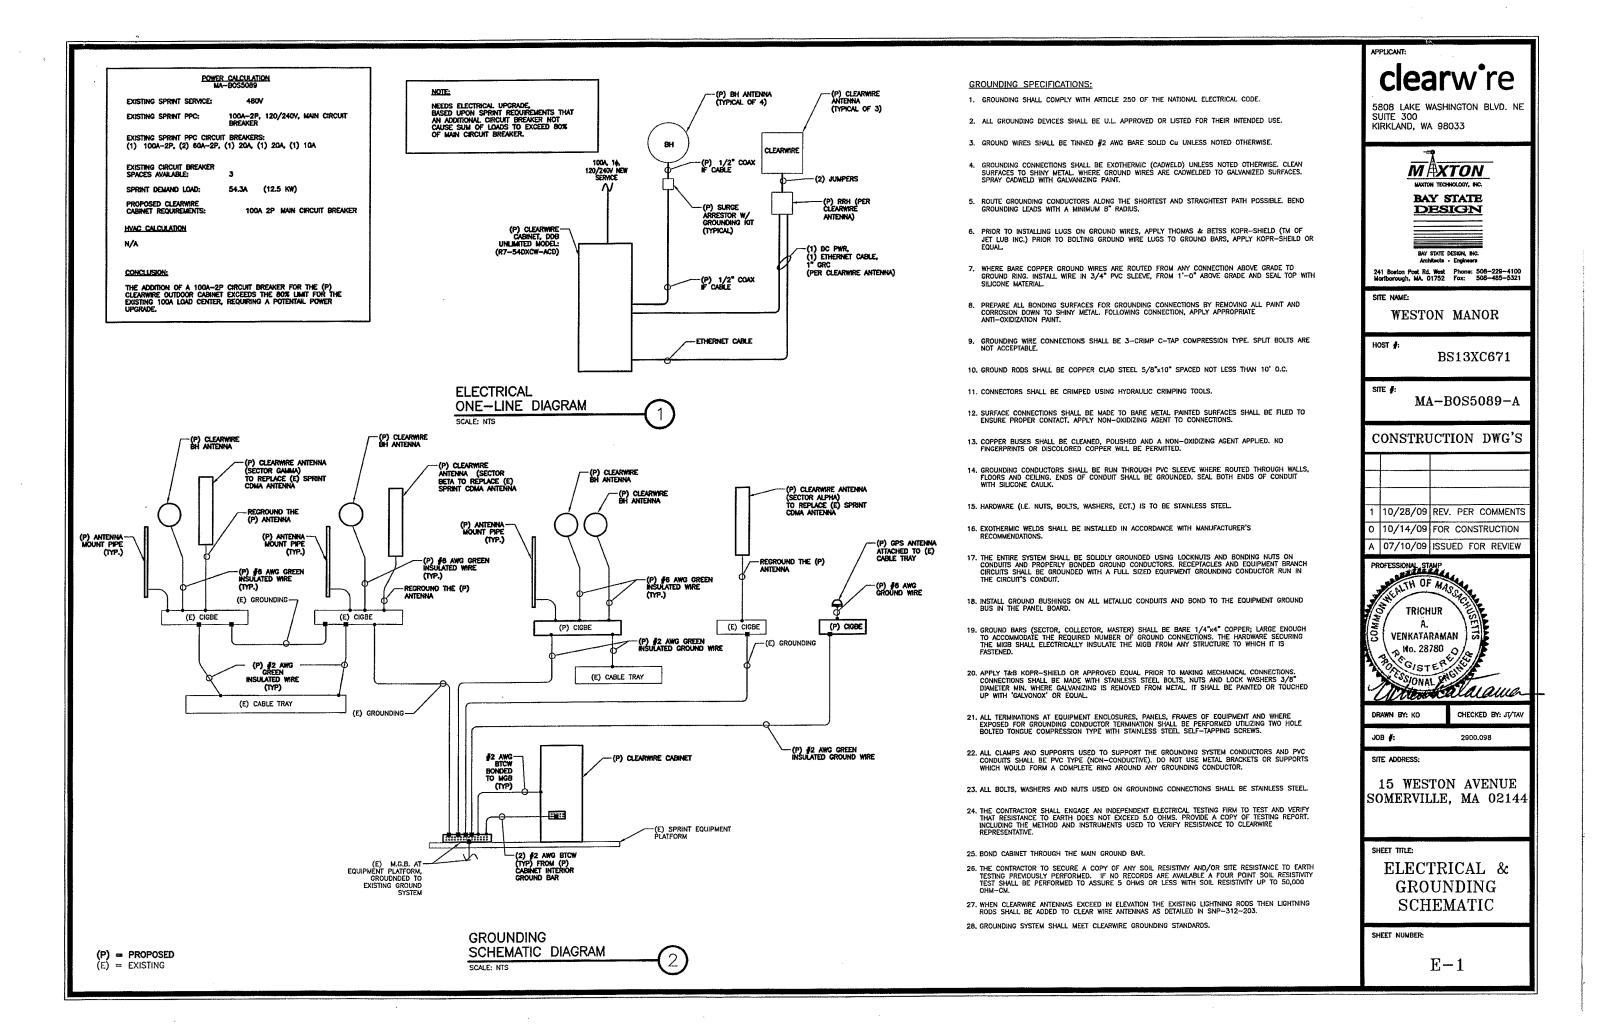

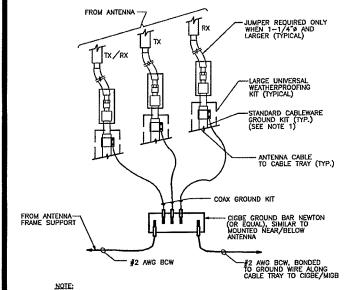

DO NOT INSTALL CABLE GROUND KIT AT A BEND AND ALWAYS DIRECT GROUND WIRE DOWN TO CIGBE.


CONNECTION OF GROUND WIRES TO GROUNDING BAR

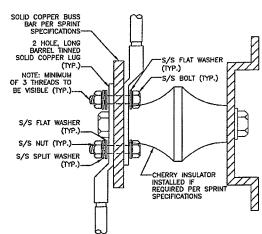

NOTES:


- 1. ALL HARDWARE 18-8 STAINLESS STEEL INCLUDING SPLIT WASHERS.
- COAT WIRE END WITH ANTI—OXIDATION COMPOUND PRIOR TO INSERTION LUG BARREL AND CRIMPING.
- 3. APPLY ANTI-OXIDATION COMPOUND BETWEEN ALL LUGS AND BUSS BARS PRIOR TO MATING AND BOLTING.

GROUND LUG DETAIL

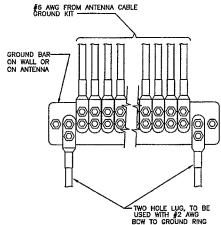

CONTRACTOR TO UTILIZE KOPR-SHIELD (THOMAS & BETTS)
 ON ALL LUG CONNECTIONS.

INSTALLATION OF GROUND WIRE TO GROUND BAR

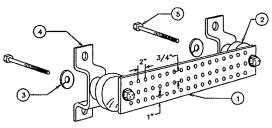


- 1- COPPER HARGER GROUND BAR, 1/4"X 4"X 20", GBIT 14420 J 2-7 HOLE CENTERS TO MATCH NEMA DOUBLE LUG CONFIGURATION 2- STANDOFF INSULATORS, NEWTON INSTRUMENT CAT. NO. 3061-4

- 2- 5/8" LOCKWASHERS, OR EQUAL
 4- WALL MOUNTING BRACKET, NEWTON INSTRUMENT CO. CAT NO. A-6056 OR EQUAL
 5- 5/8-11 X 1" HEX HEAD CAP SCREW BOLT


NOTE: ALL BOLTS, NUTS, WASHERS, AND LOCK WASHERS SHALL BE 18-8 STAINLESS STEEL.

GROUNDING - STANDARD DETAIL GROUND BAR

-1/2" JUMPERS

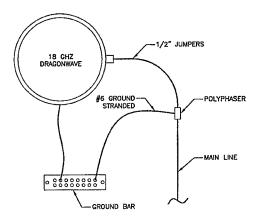


18 GHZ DRAGONWAVE GROUNDING

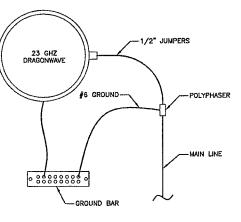

23 GHZ DRAGONWAVE GROUNDING

(6)

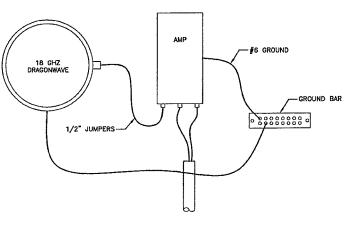

18 GHZ DRAGONWAVE/ AMP GROUNDING

ANDREW

ANDREW GROUNDING

8

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BAY STATE DESIGN

BAY STATE DESIGN, INC.

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WESTON MANOR

HOST #:

BS13XC671

MA-BOS5089-A

CONSTRUCTION DWG'S

10/28/09 REV. PER COMMENTS 10/14/09 FOR CONSTRUCTION

A 07/10/09 ISSUED FOR REVIEW



DRAWN BY: KO

CHECKED BY: JT/TAV 2900.098

JOB #:

15 WESTON AVENUE SOMERVILLE, MA 02144

SHEET TITLE:

ANTENNA GROUNDING DETAILS

SHEET NUMBER:

E-2